

WEST PARK CITY HALL

LOBBY TRANSACTION COUNTER IMPROVEMENTS

1965 S. State Road 7, West Park, FL 33023

FEBRUARY 20th, 2014

Project No. 13-014


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ARCHITECTURE, INTERIOR & PROJECT MANAGEMENT

1915 Northwest 171st Street Miami, Florida 33056


Tel: 305.670.4898 Fax: 877.867.9424

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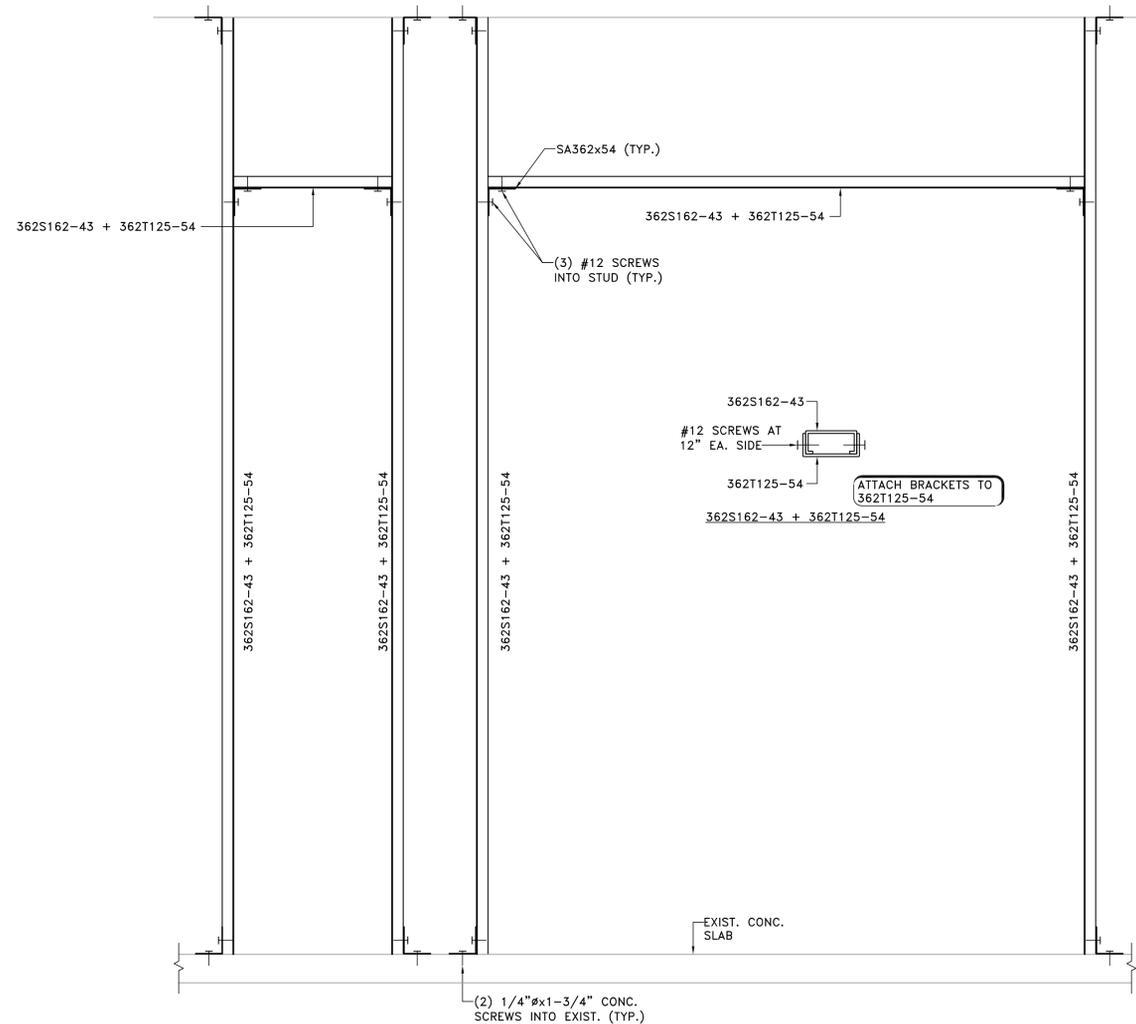
4. GLASS CLAMP DETAIL

SCALE: 6" = 1'-0"

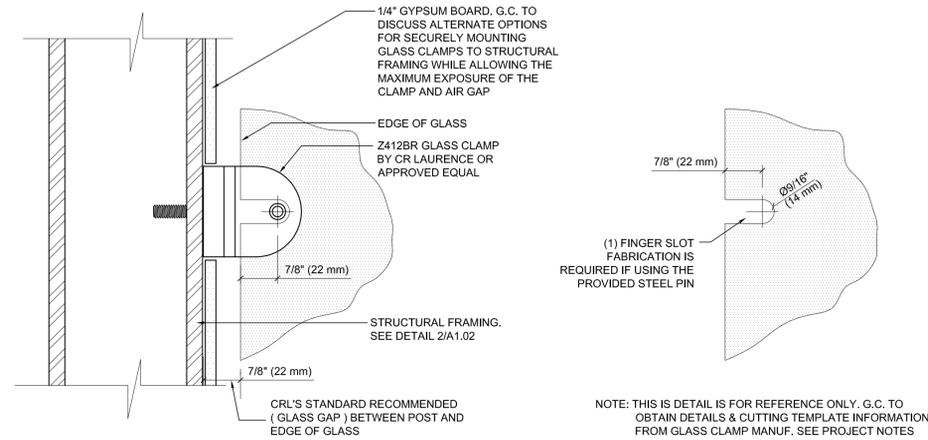


3. GLASS CLAMP DETAIL

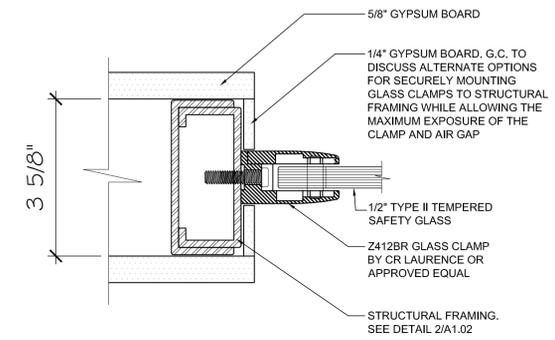SCALE: 6" = 1'-0"



2. STRUCTURAL REINFORCING ELEVATION

SCALE: 1" = 1'-0"

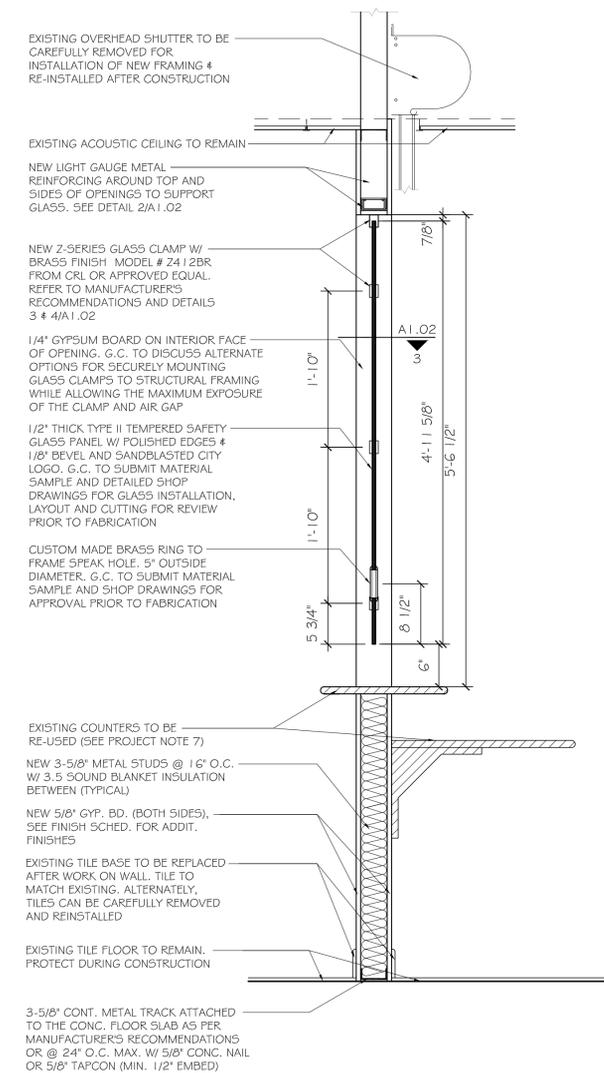

1. SECTION

SCALE: 1" = 1'-0"




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Interior Improvements For:
**West Park City Hall
Lobby Transaction Counter**
1965 S. State Road 7
West Park, Florida 33023




Zamarr T. Brown, RA
FILE NAME:
DRAWN BY: J. Flowers
QA/QC BY: Z. Brown
JOB NO.: 13-014
DATE: 02/20/14

REVISIONS	
12/31/13	As-built Dwgs
01/08/14	Design Dev.
02/20/14	100% CD's

SHEET TITLE
DETAILS

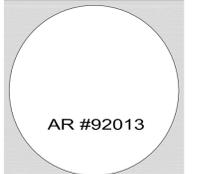DRAWING NO.
A1.02

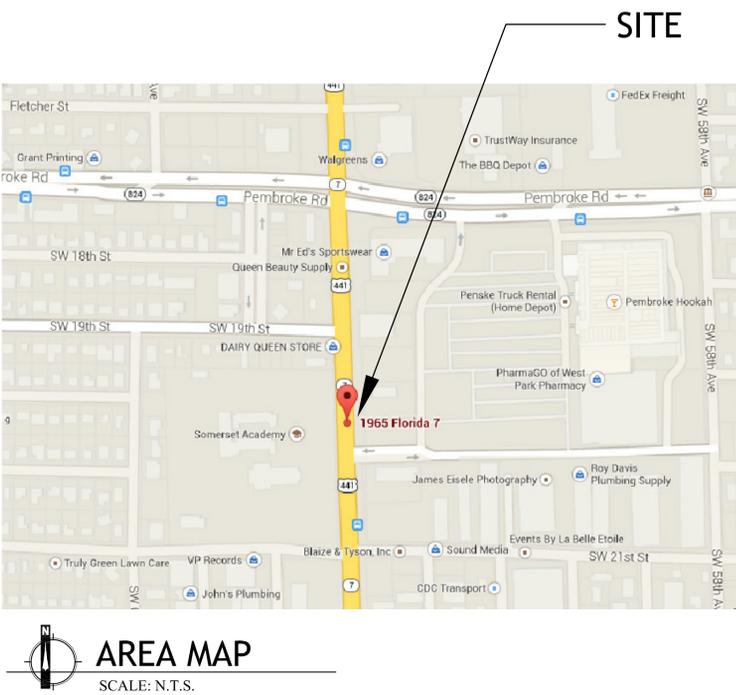

AREA MAP
SCALE: N.T.S.



AERIAL PLAN
SCALE: N.T.S.

GENERAL NOTES

1. THE CONTRACTOR SHALL FURNISH ALL MATERIALS, EQUIPMENT LABOR AND OTHER FACILITIES NECESSARY FOR THE EXECUTION OF THE WORK. ALL MATERIALS SHALL BE NEW AND BOTH WORKMANSHIP AND MATERIALS SHALL BE OF GOOD QUALITY. THE CONTRACTOR SHALL, IF REQUIRED, FURNISH SATISFACTORY EVIDENCE AS TO THE MATERIALS USED.
2. THE CONTRACTOR SHALL VERIFY ALL DIMENSIONS. THE CONTRACTOR SHALL NOTIFY THE ARCHITECT OF ANY ERRORS, INCONSISTENCIES, OR OMISSIONS HE/SHE MAY DISCOVER ON DRAWINGS.
3. THE GENERAL CONTRACTOR SHALL COORDINATE AND ASSURE ALL CLEARANCES REQUIRED FOR LIGHT FIXTURES, PLUMBING, STRUCTURAL, ETC., PRIOR TO INSTALLATION.
4. ALL SPECIFIC INFORMATION OMITTED FROM THESE DWGS. AS THEY RELATE TO CONSTRUCTION SHALL BE THE CONTRACTOR'S RESPONSIBILITY TO PROVIDE THE OWNER WITH SUFFICIENT LEAD TIME SO AS NOT TO DELAY THE PROGRESS OF THE PROJECT.
5. ALL NEW CONSTRUCTION FINISHES, BOTH INTERIOR AND EXTERIOR SHALL MATCH THE ADJACENT FINISHES U.N.O.
6. ALL WORK SHALL COMPLY WITH THE LATEST APPLICABLE CODE AND ALL MATERIAL SHALL COMPLY WITH LATEST APPLICABLE STANDARDS.
7. CONTRACTOR IS TO REVIEW THE EXISTING AREA OF WORK AND FAMILIARIZE THEMSELVES WITH ALL EXISTING CONDITIONS.
8. IT IS THE CONTRACTOR'S RESPONSIBILITY TO ASSURE THAT THE BUILDING COMPONENTS UTILIZED ARE INSTALLED IN STRICT ACCORDANCE WITH THESE DWGS. AND ALL PREVAILING PERTINENT BUILDING CODES.
9. ALL NEW WOOD FRAMING IN CONTACT WITH CONCRETE TO BE PRESSURE TREATED (TYPE "C").
10. THE CONTRACTOR IS TO PATCH AND REPAIR AS REQUIRED AFTER ALL TRADES.
11. ALL DRAWINGS AND WORK MUST COMPLY WITH THE A.D.A. GUIDELINES.
12. THIS SET OF WORKING DRAWINGS SHALL BE ADDRESSED AS A COMPLETE SET, AND IT SHALL NOT BE USED IN PARTS. IT IS THE RESPONSIBILITY OF THE CONTRACTOR TO COORDINATE THE SET OF DRAWINGS WITH ALL TRADES, SO THAT THE WORK WILL BE PERFORMED CORRECTLY AND COORDINATED AMONG ALL TRADES.
13. NO ASSUMPTION SHALL BE MADE BY THE CONTRACTORS. ANY CLARIFICATIONS NEEDED IN THE PLANS SHALL NEVER BE ASSUMED BY THE CONTRACTOR. THE ARCHITECT WILL CLARIFY ANY QUESTIONS, IF AND WHEN NEEDED IN A REASONABLE AND TIMELY MANNER.
14. THE CONTRACTOR IS TO COORDINATE THE WORK OF ALL OTHER SUBCONTRACTORS AND TRADES, WHETHER HIS OWN OR THOSE OF ANY SEPARATE CONTRACTORS ACQUIRED BY THE OWNER.
15. THE CONTRACTOR SHALL FURNISH AND INSTALL ALL MINOR ITEMS WHICH ARE OBVIOUS, REASONABLE AND NECESSARY TO COMPLETE ANY INSTALLATION.
16. THE ARCHITECT ACCEPTS NO RESPONSIBILITY FOR THE QUALITY OF MATERIALS SELECTED AS REQUIRED BY THESE DWGS., NOR FOR THE WORKMANSHIP PROVIDED IN THE INSTALLATION OF THE SAME.
17. DRAWINGS FROM VARIOUS DISCIPLINES ARE INTERRELATED, WHAT IS REQUIRED BY ONE SHALL BE AS BINDING AS IF REQUIRED BY ALL. COMPLEMENTARY COMPONENTS BETWEEN DISCIPLINES, REASONABLY INFERRED AS BEING NECESSARY TO PRODUCE INTENDED RESULTS SHALL BE DEEMED PART OF THE CONTRACTOR'S EXPECTED PERFORMANCE.
18. THE CONTRACTOR SHALL BE RESPONSIBLE FOR IMMEDIATE AND DAILY CLEANING AND REMOVAL OF ALL DEBRIS UNTIL PREMISES ARE ACCEPTED IN A CLEAN, HABITABLE CONDITION BY OWNER.
19. THE CONTRACTOR SHALL PROVIDE PROPER SAFEGUARD IN COMPLIANCE WITH LOCAL CODE AND ALL APPLICABLE CODES DURING ALL PHASES OF CONSTRUCTION.

SCOPE OF WORK

PROJECT	DESCRIPTION
CITY OF WEST PARK CITY HALL TRANSACTION COUNTER IMPROVEMENTS	
OWNER CITY OF WEST PARK	
TENANT N/A	
LOCATION 1965 S. STATE ROAD 7, WEST PARK, FL 33023	INTERIOR IMPROVEMENTS TO THE LOBBY OF THE CITY OF WEST PARK CITY HALL TO ADD A SECURITY TRANSACTION GLASS WINDOW TO THE EXISTING TRANSACTION COUNTER OPENINGS. WORK SHALL INCLUDE FRAMING TO SUPPORT GLASS LOADS, DRYWALL, GLASS INSTALLATION, PAINTING & MINOR TILE WORK. ALTERATIONS ARE CONSIDERED TO BE LEVEL 1

GOVERNING CODES

- NOTE: NOT ALL THE FOLLOWING CODES MAY BE APPLICABLE.
- ADA STANDARDS FOR ACCESSIBLE DESIGN - 2010 EDITION
 - FLORIDA ACCESSIBILITY CODE - 2012 EDITION
 - FLORIDA BUILDING CODE (FBC) - 2010 EDITION
 - FLORIDA FIRE PREVENTION CODE - 2010 EDITION
 - NFPA 101 LIFE SAFETY CODE - 2012 EDITION
 - FLORIDA STATUTE 633 - LATEST EDITION

CODE STATEMENT

TO THE BEST OF THE ARCHITECT'S / ENGINEERS' KNOWLEDGE, THE DRAWINGS AND SPECIFICATIONS SUBMITTED HEREIN ARE COMPLIANT WITH ALL APPLICABLE CODES AS DETERMINED BY THE LOCAL AUTHORITY.

DRAWING INDEX

CVR	COVER SHEET
GO.01	DRAWING INDEX & GENERAL NOTES
	ARCHITECTURAL
A 0.01	STANDARD ABBREVIATIONS & SYMBOLS
A 1.01	PROPOSED FLOOR PLAN & ELEVATION
A 1.02	DETAILS
XX	BACK COVER SHEET



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12/31/13	As-built Dwgs
01/08/14	Design Dev.
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SHEET TITLE
DWG INDEX
& GENERAL NOTES

DRAWING NO.

G0.01

MARY SAUNDERS PARK

NEW COMPUTER LAB BUILD-OUT

4750 SW 21st Street, West Park, FL 33023

DECEMBER 4th, 2013

Project No. 13-014

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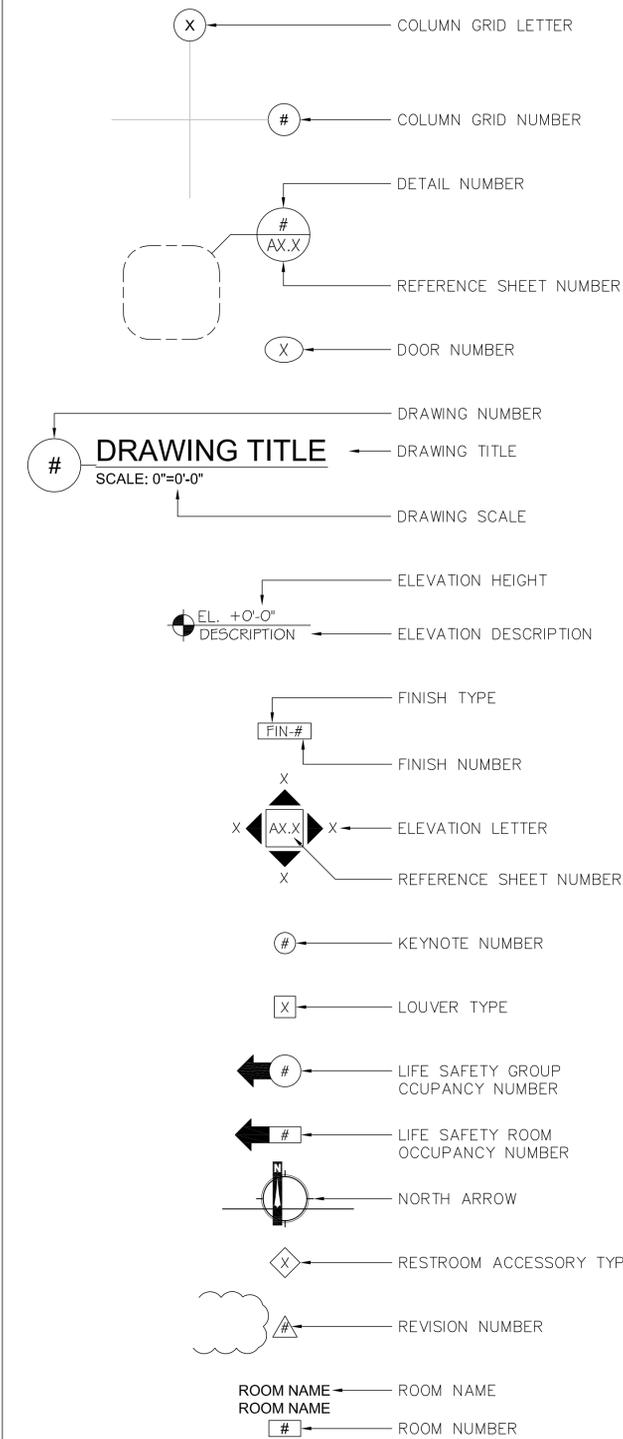
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ABBREVIATIONS


<p>A/C AIR CONDITIONING A.C.T. ACOUSTICAL CEILING TILE ADJ. ADJUSTABLE A.F.F. ALUMINUM ALUM. ABOVE FINISHED FLOOR APPROX. APPROXIMATELY ARCH. ARCHITECT, ARCHITECTURAL ASPH. ASPHALT AVE. AVENUE AVG. AVERAGE</p> <p>BD. BOARD BITUM. BITUMINOUS BLDG. BUILDING BLK. BLOCK BLVD. BOULEVARD B.M. BENCH MARK BOT. BOTTOM BRG. BEARING</p> <p>CAB. CABINET C.B. CATCH BASIN C.B.S. CONCRETE BLOCK WITH STUCCO CEM. CEMENT, CEMENTITIOUS CIRC. CIRCULAR C.J. CONTROL JOINT C/L CENTERLINE C.L.F. CHAIN LINK FENCE CLG. CEILING CLO. CLOSET CLR. CLEAR C.M.U. CONCRETE MASONRY UNIT COL. COLUMN CONC. CONCRETE CONT. CONTINUOUS CORR. CORRIDOR CPT. CARPET C.T. CERAMIC TILE CTR. CENTER</p> <p>DIA. DIAMETER DBL. DOUBLE DEPT. DEPARTMENT DET. DETAIL DEMO. DEMOLITION D.F. DRINKING FOUNTAIN DIAG. DIAGONAL DIM. DIMENSION DN. DOWN DR. DOOR DWG. DRAWING DWR. DRAWER</p> <p>E. EAST EA. EACH E.I.F.S. EXTERIOR INSULATED FIRE SYSTEM E.J. EXPANSION JOINT EL. ELEVATION ELEC. ELECTRICAL ELEV. ELEVATOR E.M.C. EQUILIBRIUM MOISTURE CONTENT EMER. EMERGENCY ENCL. ENCLOSURE EQ. EQUAL EQUIP. EQUIPMENT EXIST. EXISTING EXP. EXPOSED EXT. EXTERIOR E.W.C. ELECTRIC WATER COOLER E.W.H. ELECTRIC WATER HEATER</p> <p>F.D. FLOOR DRAIN F.A. FIRE ALARM F.E. FIRE EXTINGUISHER F.E.C. FIRE EXTINGUISHER CABINET F.F.E. FINISHED FLOOR ELEVATION F.H. FIRE HYDRANT FIN. FINISH FLR. FLOOR FLUOR. FLUORESCENT FT. FEET, FOOT FTG. FOOTING</p> <p>GA. GAUGE GALV. GALVANIZED G.C. GENERAL CONTRACTOR G.W.B. GYPSUM WALL BOARD GYP. GYPSUM</p>	<p>H.B. HOSE BIBB H.C.WD. HOLLOW CORE HDWD. HARDWOOD HDWR. HARDWARE H.M. HOLLOW METAL HORIZ. HORIZONTAL H.P. HIGH POINT HR. HOUR HT. HEIGHT HWY. HIGHWAY</p> <p>I.D. INSIDE DIAMETER IN. INCH INT. INTERIOR INV. INVERT INSUL. INSULATION I.R. IMPACT RESISTANT</p> <p>JAN. JANITOR, JANITORIAL JOINT</p> <p>K.D.A.T. KILN-DRIED AFTER TREATMENT KIT. KITCHEN</p> <p>LAM. LAMINATE LAV. LAVATORY L.P. LOW POINT LT. LIGHT</p> <p>MACH. MACHINE MAT'L MATERIAL MAX. MAXIMUM MECH. MECHANICAL MFR. MANUFACTURER M.H. MAN HOLE MIN. MINIMUM MIR. MIRROR MISC. MISCELLANEOUS M.O. MASONRY OPENING MOISTURE RESISTANT M/S.L. MEAN SEA LEVEL MTD. MOUNTED MTL. METAL</p> <p>N. NORTH N/A NOT APPLICABLE N.G.V.D. NATIONAL GEODETIC VERTICAL DATUM N.I.C. NOT IN CONTRACT NO. NUMBER N.O.A. NOTICE OF ACCEPTANCE NOM. NOMINAL N.T.S. NOT TO SCALE</p> <p>O.C. ON CENTER O.D. OUTSIDE DIAMETER O.H. OVERHANG OPNG. OPENING</p> <p>PL. PLATE P/L PROPERTY LINE PLAS. PLASTER P. LAM. PLASTIC LAMINATE PLYWD. PLYWOOD PNT. PAINT P.T. PRESSURE TREATED PREFAB. PREFABRICATED PROP. PROPERTY P.S.I. POUNDS PER SQUARE INCH PT. POINT PV. PHOTOVOLTAIC PVC. POLYVINYL CHLORIDE PVL. PHOTOVOLTAIC LAMINATE</p> <p>QTY. QUANTITY</p> <p>R.D. ROOF DRAIN REINF. REINFORCEMENT REQ'D. REQUIRED REV. REVERSE, REVISION RM. ROOM R.O. ROUGH OPENING R/W. RIGHT OF WAY R.W.L. RAIN WATER LEADER</p>	<p>S. SOUTH S.C. SOLID CORE SECT. SECTION SHT. SHEET SIM. SIMILAR SLD. SEALED SPEC. SPECIFICATION SQ. SQUARE SS. STAINLESS STEEL ST. STEEL STD. STANDARD STL. STEEL STND. STAINED STOR. STORAGE STRUC. STRUCTURAL SUSP. SUSPENDED, SUSPENSION SYS. SYSTEM</p> <p>T&B TOP AND BOTTOM T.B. TIE BEAM T.B.D. TO BE DETERMINED TEL. TELEPHONE TEMP. TEMPERATURE T&G. TONGUE AND GROOVE THK. THICK, THICKNESS THR. THRESHOLD T.O. TOP OF T.O.B. TOP OF BEAM T.O.S. TOP OF SLAB T.V. TELEVISION TYP. TYPICAL</p> <p>U.N.O. UNLESS NOTED OTHERWISE</p> <p>V.C.T. VINYL COMPOSITION TILE VERT. VERTICAL VEST. VESTIBULE V.I.F. VERIFY IN FIELD VIN. VINYL V.U.A. VEHICULAR USE AREA</p> <p>W. WEST W/ WITH W.C. WATER CLOSET WOOD W/O WITHOUT WP. WATERPROOF W.W.F. WELDED WIRE FABRIC</p>
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GRAPHIC SYMBOLS

TAGS



LINETYPES

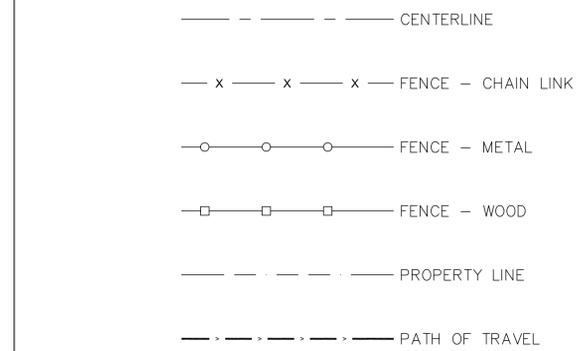

MATERIALS

<u>CONCRETE</u>				
FINISH		STRUCTURAL		
<u>EARTHWORK</u>				
BACKFILL		GRAVEL		
		UNDISTURBED		
<u>FINISHES</u>				
PLASTER OR STUCCO				
<u>GLASS</u>				
GLASS		GLASS BLOCK		
<u>INSULATION</u>				
BATT		RIGID		
<u>MASONRY</u>				
BRICK		CONC. BLOCK		
<u>METAL</u>				
ALUMINUM	STEEL	BRASS OR BRONZE		
<u>PLASTIC</u>				
PLASTIC				
<u>STONE</u>				
CAST STONE	CUT STONE	SLATE		
<u>WOOD</u>				
CORK	FINISH	PLYWOOD	ROUGH	




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A A 2 6 0 0 2 6 6 6

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Interior Alterations and Improvements For:
Mary Saunders Park
New Computer Lab Build-Out
4750 SW 21st Street
West Park, Florida 33023



Zamarr T. Brown, RA

FILE NAME:
DRAWN BY : J. Flowers
QA/QC BY : Z. Brown
JOB NO. : 13-014
DATE : 12/04/13

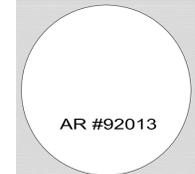REVISIONS

11/01/13	As-built Dwg's
11/07/13	Design Dev.
12/04/13	100% CD's
08/01/14	Owner Changes

SHEET TITLE
STANDARD
ABBREVIATIONS
& SYMBOLS

DRAWING NO.

A0.01




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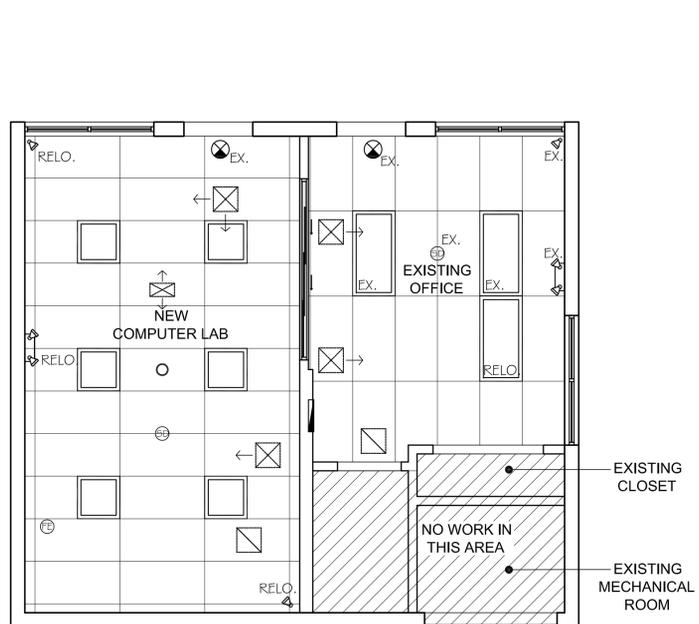
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03/19/15	Bldg. Dept. Comments

SHEET TITLE
PROPOSED FLOOR PLANS

DRAWING NO.

A1.01

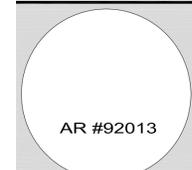


PROPOSED REFLECTED CEILING PLAN

SCALE: 1/4" = 1'-0"

RCP LEGEND	
	2x4' FLOURESCENT LIGHT FIXTURE W/ PRISMATIC LENS
	2x2' FLOURESCENT LIGHT FIXTURE W/ PRISMATIC LENS
	REPLACED SUPPLY AIR DIFFUSER BY NAILOR OR APPROVED EQUAL
	REPLACED RETURN AIR DIFFUSER BY NAILOR OR APPROVED EQUAL
	LIGHTED EXIT SIGN
	SMOKE DETECTOR
	EMERGENCY LIGHT FIXTURE
	SECURITY CAMERA
	RECESSED FLOURESCENT DOWNLIGHT FIXTURE

NOTE: IN ADDITION TO OTHER INDICATION IN LEGEND: SYMBOLS DENOTED WITH "EX" ARE EXISTING TO REMAIN SYMBOLS DENOTED WITH "RELO" ARE RELOCATED SYMBOLS WITH NO DENOTATION ARE NEW

NOTE: LIGHT FIXTURE SELECTIONS SHALL BE PROVIDED BY ARCHITECT. G.C. TO SUBMIT SHOP DRAWINGS FOR ALL NEW ITEMS TO ARCHITECT FOR APPROVAL

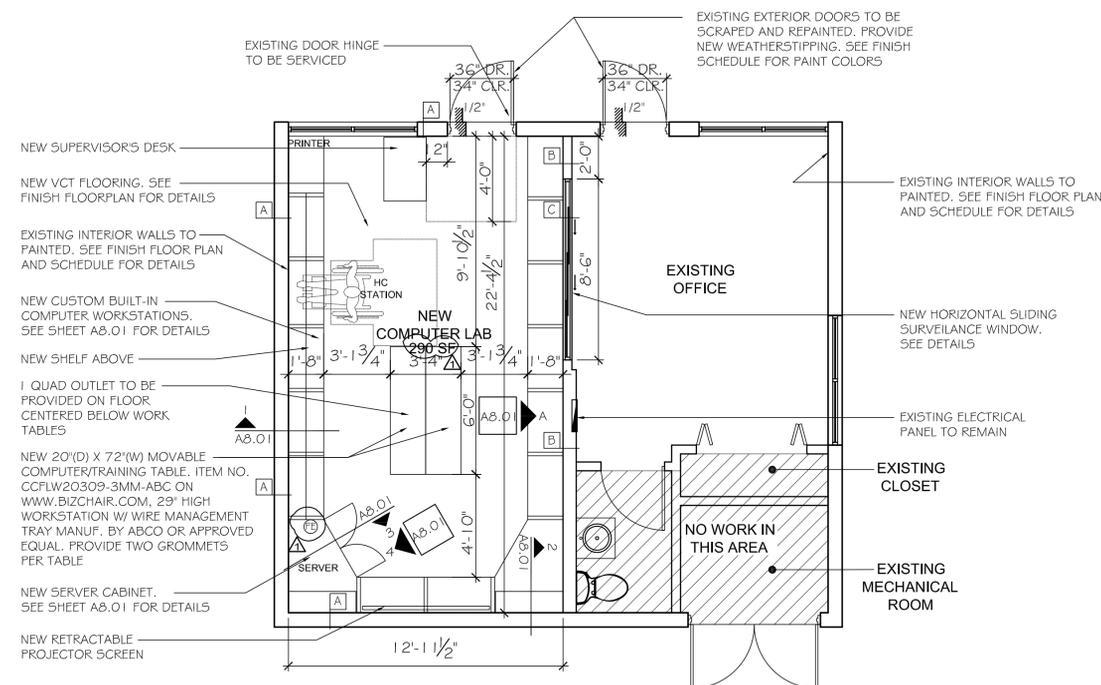


PROPOSED FLOOR PLAN

SCALE: 1/4" = 1'-0"

FLOOR PLAN LEGEND	
	EXISTING CMU WALL TO REMAIN
	EXISTING DRYWALL PARTITION TO REMAIN
	EXISTING BUILDING AREAS NOT IN SCOPE - NO WORK IN THIS AREA
	NEW 10 LB. ABC FIRE EXTINGUISHER

PROJECT SPECIFIC NOTES	
1.	G.C. TO EXAMINE ALL EXISTING MATERIALS AND FINISHES. ANY MATERIALS AND FINISHES THAT CAN BE SALVAGED SHALL BE REUSED.
2.	G.C. TO FIELD VERIFY EXISTING DIMENSIONS AND CONDITIONS.
3.	G.C. TO EXAMINE CONDITION OF ALL EXISTING FRAMING, SUBFLOORING AND SHEATHING TO REMAIN AND ADVISE ARCHITECT/ENGINEER OF ANY DETERIORATED AREAS.
4.	PROVIDE A MINIMUM OF 3/4" PLYWOOD BACKING BETWEEN STUDS FOR ALL WALL HUNG PLUMBING FIXTURES, CABINETS AND CLOSET SHELVING.
5.	FLOOR ELEVATIONS ARE ASSUMED, V.I.F.

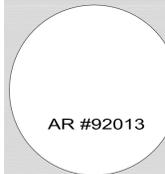

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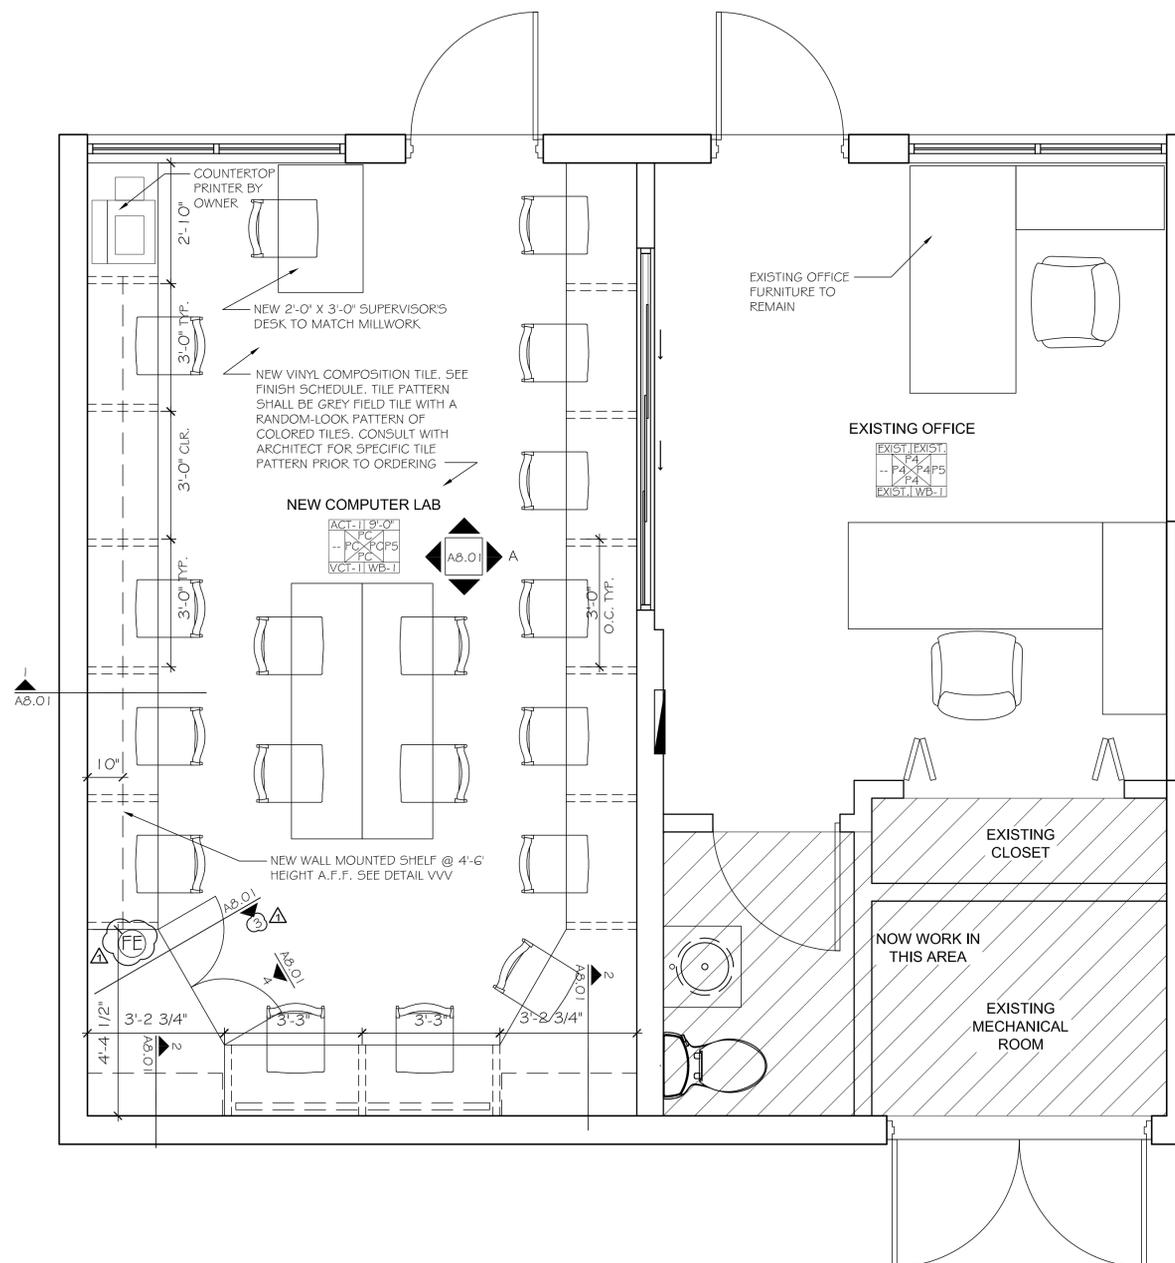
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12/04/13	100% CD's
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SHEET TITLE FINISH FLOOR PLAN & SCHEDULE

DRAWING NO.

A9.01



FURNITURE & EQUIPMENT SCHEDULE

PROJECTOR
TO BE DONATED FROM THE COMMISSION CHAMBERS. G.C. TO COORD. W/ OWNER FOR REMOVAL AND INSTALLATION.

PROJECTION SCREEN
ELITE PROJECTION SCREEN MODEL # M100NMV1 WALL MOUNTED. 4:3 RATIO. WIDTH 60" X HEIGHT 45", OR APPROVED EQUAL


CHAIR
AYR STACKER BY ALLSEATING. W/ POLYPROPYLENE SEAT AND BACK, SILVER FRAME, TILE CASTERS & TITANIUM COLOR, OR APPROVAL EQUAL

MOVABLE COMPUTER/TRAINING TABLES (QUANTITY OF 2)
ITEM NO. CCFLW20309-3MM-ABC AVAILABLE ON WWW.BIZCHAIR.COM. 29" HIGH WORKSTATION W/ WIRE MANAGEMENT TRAY MANUF. BY ABCO OR APPROVED EQUAL. SIZE 20"(D) X 72"(W). PROVIDE TWO GROMMETS PER TABLE. FINISH AND OTHER OPTIONS SHALL BE SELECTED BY ARCHITECT & OWNER PRIOR TO ORDERING.

FINISH SCHEDULE

WALL FINISHES		CEILING FINISHES	
PAINT		ACT-1 2'X4' ACOUSTIC CEILING TILES BY ARMSTRONG FINE FISSURED TEGULAR (MEDIUM TEXTURE) TILES W/ 9/16" STANDARD INTERLUDE XL SUSPENSION GRID	
PC	PAINT COMBINATION WITH P1, P2 AND P3. SEE INTERIOR ELEVATIONS.		
P1	INTERIOR GRADE PAINT (2 COATS - SATIN FINISH) - SW 7067		
P2	INTERIOR GRADE PAINT (2 COATS - SATIN FINISH) - SW 6918		
P3	INTERIOR GRADE PAINT (2 COATS - SATIN FINISH) - SW 7004		
P4	INTERIOR GRADE PAINT (2 COATS - SATIN FINISH) - SW 6654		
P5	COMMERCIAL GRADE METAL PAINT (FOR METAL DOORS, JAMBS ETC.) - SW 7067		
P6	COMMERCIAL GRADE METAL PAINT (FOR METAL DOORS, JAMBS ETC.) - COLOR TO MATCH EXISTING EXTERIOR DOORS		
WALL BASE		GENERAL NOTES	
WB-1	JOHNSONITE RUBBER WALL BASE 1/8" - COLOR: 20-CHARCOAL	1. ALL FINISHES ARE AS NOTED, OR ALTERNATE AS APPROVED BY ARCHITECT AND OWNER. G.C. SHALL CONFIRM FINISH SELECTIONS WITH OWNER PRIOR TO ORDERING.	
FLOOR FINISHES		2. ALL PAINT SHALL BE SHERWIN WILLIAMS OR APPROVED EQUAL.	
VCT-1	VINYL COMPOSITION TILE - ARMSTRONG STANDARD EXCELO IMPERIAL TEXTURE 51915 CHARCOAL AND STANDARD EXCELO RAVE IN 57510, 57513 & 57516	2. G.C. SHALL PROVIDE A 2'X2' PAINT SAMPLE ON WALL IN OFFICE AND A 2' WIDE FULL-HEIGHT PAINT SAMPLE IN COMPUTER LAB FOR REVIEW BY ARCHITECT AND OWNER FOR FINAL CONFIRMATION OF PAINT COLORS PRIOR TO PURCHASING FULL PAINT QUANTITIES.	

FINISH FLOOR PLAN
SCALE: 1/2" = 1'-0"

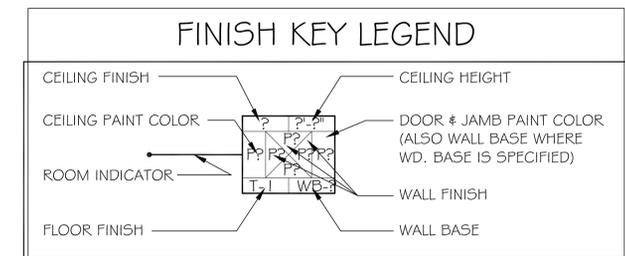




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Fax: 877.867.9424
AA 26002666

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Interior Alterations and Improvements For:
**Mary Saunders Park
New Computer Lab Build-Out**
4750 SW 21st Street
West Park, Florida 33023



Zamarr T. Brown, RA

FILE NAME:

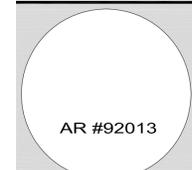DRAWN BY: J. Flowers

QA/QC BY: Z. Brown

JOB NO.: 13-014

DATE: 12/04/13


REVISIONS

11/01/13	As-built Dwgs
11/07/13	Design Dev.
12/04/13	100% CD's
08/01/14	Owner Changes


**SHEET TITLE
DEMOLITION
PLANS**

DRAWING NO.

AD1.01

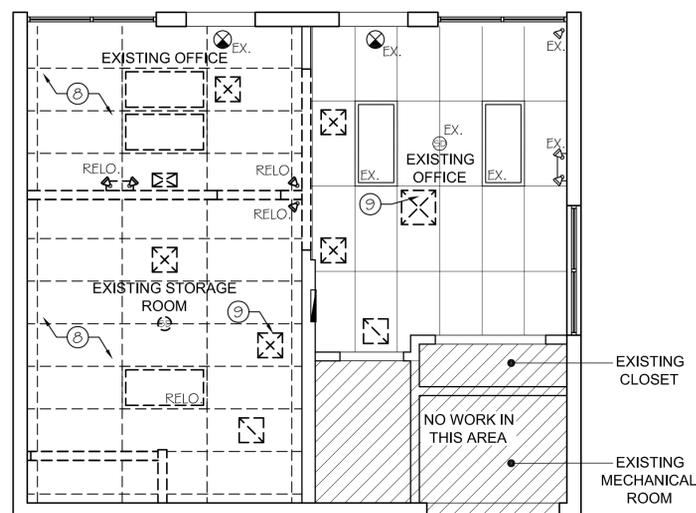

DEMOLITION REFLECTED CEILING PLAN
SCALE: 1/4" = 1'-0"

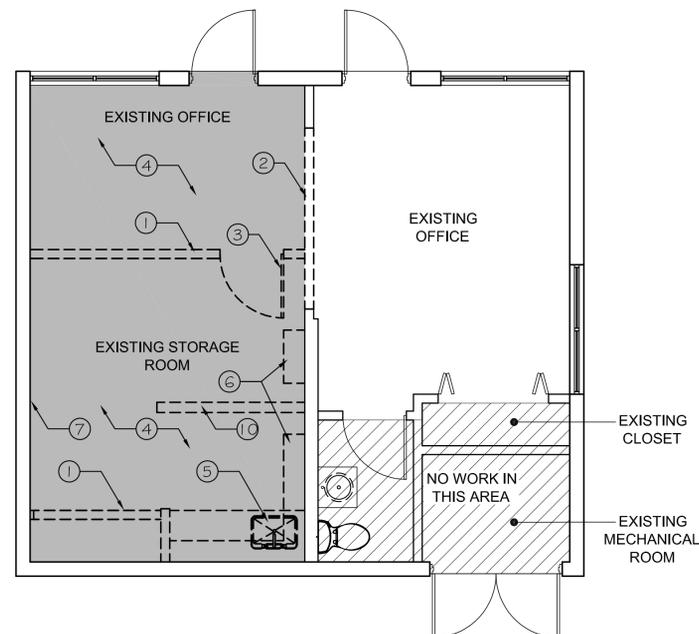

DEMOLITION FLOOR PLAN
SCALE: 1/4" = 1'-0"

DEMO RCP LEGEND

	EXISTING 2"x4" FLOURESCENT LIGHT FIXTURE
	EXISTING SUPPLY AIR DIFFUSER
	EXISTING RETURN AIR DIFFUSER
	EXISTING LIGHTED EXIT SIGN
	EXISTING SMOKE DETECTOR
	EXISTING EMERGENCY LIGHT FIXTURE
	EXISTING SECURITY CAMERA
	EXISTING LIGHT FIXTURE OR OBJECT TO BE REMOVED, REPLACED OR RELOCATED AS INDICATED

NOTE: IN ADDITION TO OTHER INDICATION IN LEGEND: SYMBOLS DENOTED WITH "EX" ARE EXISTING TO REMAIN SYMBOLS DENOTED WITH "RELO" ARE RELOCATED

GENERAL DEMOLITION NOTES

- THE CONTRACTOR SHALL OBTAIN ALL NECESSARY CITY, STATE AND COUNTY LICENSES PRIOR TO COMMENCING CONSTRUCTION. IF SPECIAL PERMITS ARE REQUIRED FOR ANY OF THE WORK, THEY SHALL BE OBTAINED AND EXHIBITED. THE CONTRACTOR SHALL GIVE ALL NOTICES AND COMPLY WITH THE LAWS, ORDINANCES, CODES AND REGULATIONS BEARING ON THE CONDUCT OF THE WORK AS DRAWN AND SPECIFIED.
- ALL DEBRIS SHALL BE REMOVED FROM THE SITE BY CONTRACTOR AND ALL AREAS SHALL BE LEFT IN A BROOM CLEAN CONDITION AT ALL TIMES.
- THE CONTRACTOR SHALL TAKE ALL NECESSARY PRECAUTIONS TO ENSURE THE SAFETY OF THE OCCUPANTS AND WORKERS AT ALL TIMES, G.C. SHALL ALSO BE RESPONSIBLE FOR THE SECURITY OF THE SITE WHILE JOB IS IN PROGRESS AND UNTIL ITS COMPLETION.
- CONTRACTOR SHALL EXERCISE CARE DURING DEMOLITION AND REMOVAL TO ASSURE THAT ITEMS SCHEDULED FOR DEMOLITION ARE PROPERLY REMOVED AND ITEMS TO REMAIN ARE PROTECTED FROM DAMAGE.
- ALL AREAS AND ITEMS WHICH ARE DAMAGED DURING DEMOLITION SHALL BE REPAIRED AND OR REPLACED TO THE SATISFACTION OF THE OWNER / ARCHITECT AT NO ADDITIONAL COST TO OWNER.
- CONTRACTOR SHALL BE RESPONSIBLE FOR ALL DEMOLITION WORK AND REMOVAL OF DEBRIS AND EQUIPMENT UNLESS OTHERWISE NOTED.
- CARE SHALL BE TAKEN TO SALVAGE AS MUCH AS POSSIBLE.

DEMO PLAN LEGEND

	EXISTING CMU WALL TO REMAIN
	EXISTING WOOD STUD PARTITION TO REMAIN
	EXISTING BUILDING AREAS NOT IN SCOPE - NO WORK IN THIS AREA
	EXISTING FLOOR FINISH TO BE REMOVED COMPLETE
	EXISTING WALL, PARTITION OR OBJECT TO BE REMOVED, REPLACED OR RELOCATED AS INDICATED

DEMOLITION PLAN & RCP KEYNOTES

- EXISTING DRYWALL PARTITION TO BE REMOVED COMPLETE.
- PORTION OF EXISTING DRYWALL PARTITION TO BE REMOVED FOR NEW WINDOW. COORDINATE OPENING SIZE WITH PROPOSED DRAWINGS AND WINDOW MANUFACTURER PRIOR TO CUTTING WALL.
- EXISTING DOOR AND JAMB TO BE REMOVED COMPLETE.
- EXISTING FLOORING TO BE REMOVED COMPLETE.
- EXISTING COUNTER AND SINK TO BE REMOVED COMPLETE. PLUMBING FOR SINK TO BE CAPPED.
- EXISTING WALL-MOUNTED SHELVES TO BE REMOVED COMPLETE.
- REMOVE EXISTING DRYWALL FROM FLOOR TO 4' HEIGHT OR AS REQUIRED FOR BACKING AND ELECTRICAL WORK.
- EXISTING ACOUSTIC CEILING TILE AND GRID TO BE REMOVED COMPLETE.
- ALL EXISTING SUPPLY AND RETURN GRILLES SHALL BE CAREFULLY REMOVED. SEE PROPOSED RCP FOR GRILLS TO BE REPLACED. EXISTING ABANDONED A/C GRILLS, SUPPLIES AND DUCTWORK SHALL BE REMOVED COMPLETE.
- PROVIDE TRENCH FOR NEW ELECTRICAL OUTLET IN FLOOR. COOR.D WITH ELECTRICAL DRAWINGS.




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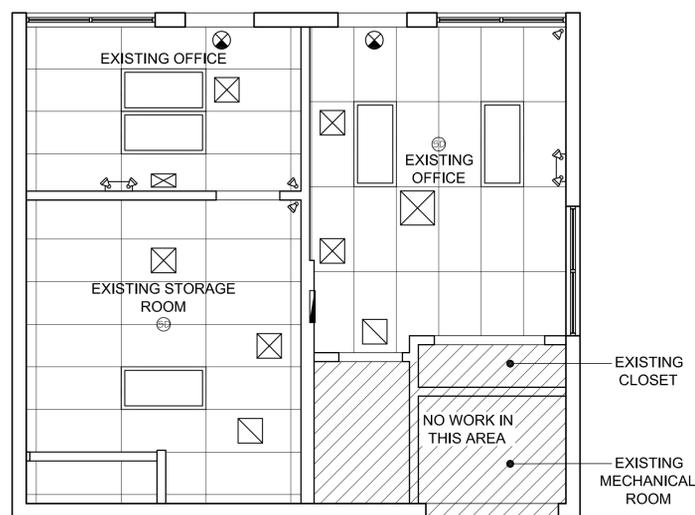
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08/01/14	Owner Changes

SHEET TITLE
**EXISTING
FLOOR PLANS**


DRAWING NO.

AE1.01

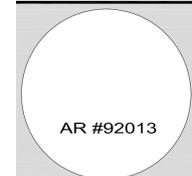

EXISTING REFLECTED CEILING PLAN

SCALE: 1/4" = 1'-0"

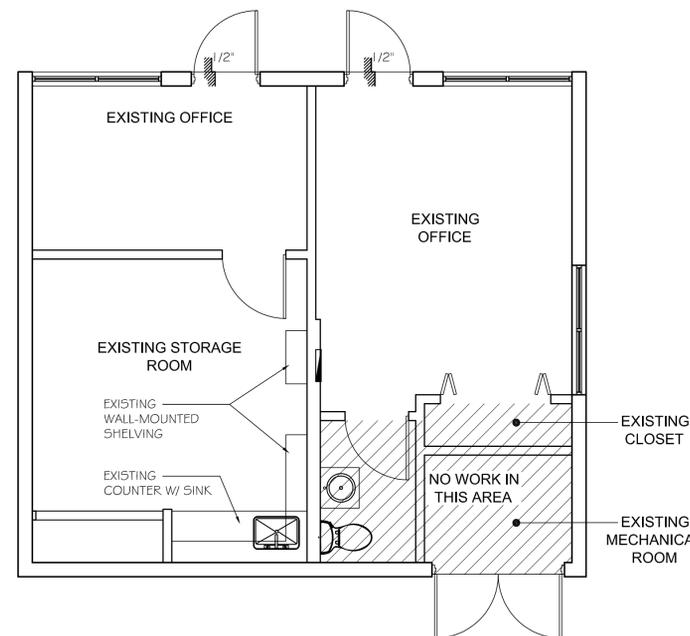

EXISTING FLOOR PLAN

SCALE: 1/4" = 1'-0"


RCP LEGEND

	EXISTING 2x4' FLOURESCENT LIGHT FIXTURE
	EXISTING SUPPLY AIR DIFFUSER
	EXISTING RETURN AIR DIFFUSER
	EXISTING LIGHTED EXIT SIGN
	EXISTING SMOKE DETECTOR
	EXISTING EMERGENCY LIGHT FIXTURE
	EXISTING SECURITY CAMERA

FLOOR PLAN LEGEND

	EXISTING CMU WALL TO REMAIN
	EXISTING DRYWALL PARTITION TO REMAIN
	EXISTING BUILDING AREAS NOT IN SCOPE - NO WORK IN THIS AREA

- PROJECT SPECIFIC NOTES
- G.C. TO EXAMINE ALL EXISTING MATERIALS AND FINISHES. ANY MATERIALS AND FINISHES THAT CAN BE SALVAGED SHALL BE REUSED.
 - G.C. TO FIELD VERIFY EXISTING DIMENSIONS AND CONDITIONS.
 - G.C. TO EXAMINE CONDITION OF ALL EXISTING FRAMING, SUBFLOORING AND SHEATHING TO REMAIN AND ADVISE ARCHITECT/ENGINEER OF ANY DETERIORATED AREAS.
 - PROVIDE A MINIMUM OF 3/4" PLYWOOD BACKING BETWEEN STUDS FOR ALL WALL HUNG PLUMBING FIXTURES, CABINETS AND CLOSET SHELVING.
 - FLOOR ELEVATIONS ARE ASSUMED, V.I.F.

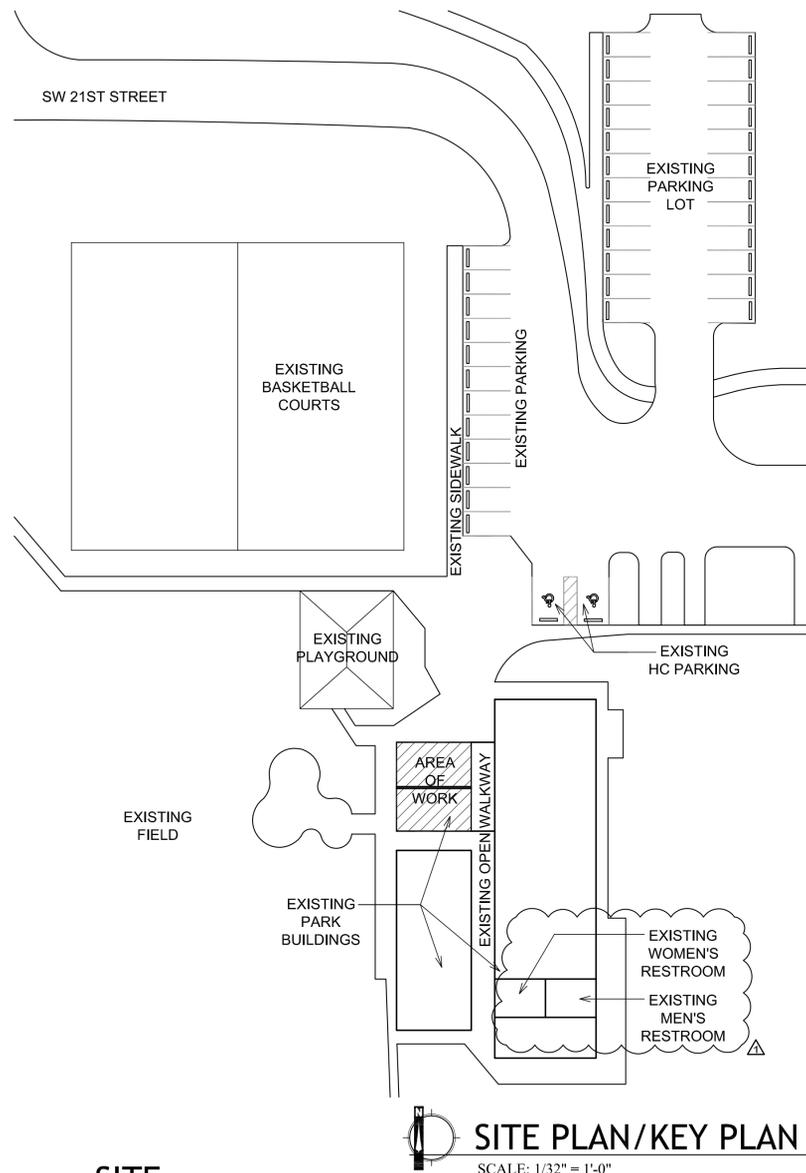

DRAWING INDEX

CVR	COVER SHEET
GO.01	DRAWING INDEX & GENERAL NOTES
	ARCHITECTURAL
A 0.01	STANDARD ABBREVIATIONS & SYMBOLS
AE 1.01	EXISTING FLOOR PLAN & RCP
AD 1.01	DEMOLITION FLOOR PLAN & RCP
A 1.01	PROPOSED FLOOR PLAN & RCP
A 8.01	PARTITION TYPES, INTERIOR ELEVATIONS & DETAILS
A 9.01	FINISH FLOOR PLAN & SCHEDULE
	ELECTRICAL
E 0.1	ELECTRICAL LEGEND, GENERAL NOTES & SPECIFICATIONS
E 1.1	ELECTRICAL FLOOR PLANS, SCHEDULES & RISER DIAGRAM
XX	BACK COVER SHEET

BLDG. & LIFE SAFETY INFO.

OCCUPANCY CLASSIFICATION: GROUP B - BUSINESS (TRAINING & SKILL DEVELOPMENT NOT WITHIN A SCHOOL OR ACADEMIC PROGRAM)
 ADJACENT OCCUPANCY: GROUP B - BUSINESS
 CONSTRUCTION TYPE: III A - UNPROTECTED

MINIMUM DOOR WIDTH: 32" MINIMUM
 EXIT ACCESS CORRIDOR RATING: N/A

OCCUPANCY BASED ON SQUARE FOOTAGE
 TYPE OF USE AREA PER OCCUPANT MIN. OCCUPANT LOAD
 B - BUSINESS 1 PERSON / 100 SF 3 PERSONS 290 SF
 PER FBC 2010 SECTION 1004.1.1 ACTUAL OCCUPANT LOAD BASED ON FURNISHINGS PROVIDED = 20 PERSONS

GENERAL NOTES

- THE CONTRACTOR SHALL FURNISH ALL MATERIALS, EQUIPMENT LABOR AND OTHER FACILITIES NECESSARY FOR THE EXECUTION OF THE WORK. ALL MATERIALS SHALL BE NEW AND BOTH WORKMANSHIP AND MATERIALS SHALL BE OF GOOD QUALITY. THE CONTRACTOR SHALL, IF REQUIRED, FURNISH SATISFACTORY EVIDENCE AS TO THE MATERIALS USED.
- THE CONTRACTOR SHALL VERIFY ALL DIMENSIONS. THE CONTRACTOR SHALL NOTIFY THE ARCHITECT OF ANY ERRORS, INCONSISTENCIES, OR OMISSIONS HE/SHE MAY DISCOVER ON DRAWINGS.
- THE GENERAL CONTRACTOR SHALL COORDINATE AND ASSURE ALL CLEARANCES REQUIRED FOR LIGHT FIXTURES, PLUMBING, STRUCTURAL, ETC., PRIOR TO INSTALLATION.
- ALL SPECIFIC INFORMATION OMITTED FROM THESE DWGS. AS THEY RELATE TO CONSTRUCTION SHALL BE THE CONTRACTOR'S RESPONSIBILITY TO PROVIDE THE OWNER WITH SUFFICIENT LEAD TIME SO AS NOT TO DELAY THE PROGRESS OF THE PROJECT.
- ALL NEW CONSTRUCTION FINISHES, BOTH INTERIOR AND EXTERIOR SHALL MATCH THE ADJACENT FINISHES U.N.O.
- ALL WORK SHALL COMPLY WITH THE LATEST APPLICABLE CODE AND ALL MATERIAL SHALL COMPLY WITH LATEST APPLICABLE STANDARDS.
- CONTRACTOR IS TO REVIEW THE EXISTING AREA OF WORK AND FAMILIARIZE THEMSELVES WITH ALL EXISTING CONDITIONS.
- IT IS THE CONTRACTOR'S RESPONSIBILITY TO ASSURE THAT THE BUILDING COMPONENTS UTILIZED ARE INSTALLED IN STRICT ACCORDANCE WITH THESE DWGS. AND ALL PREVAILING PERTINENT BUILDING CODES.
- ALL NEW WOOD FRAMING IN CONTACT WITH CONCRETE TO BE PRESSURE TREATED (TYPE "C").
- THE CONTRACTOR IS TO PATCH AND REPAIR AS REQUIRED AFTER ALL TRADES.
- ALL DRAWINGS AND WORK MUST COMPLY WITH THE A.D.A. GUIDELINES.
- THIS SET OF WORKING DRAWINGS SHALL BE ADDRESSED AS A COMPLETE SET, AND IT SHALL NOT BE USED IN PARTS. IT IS THE RESPONSIBILITY OF THE CONTRACTOR TO COORDINATE THE SET OF DRAWINGS WITH ALL TRADES, SO THAT THE WORK WILL BE PERFORMED CORRECTLY AND COORDINATED AMONG ALL TRADES.
- NO ASSUMPTION SHALL BE MADE BY THE CONTRACTORS. ANY CLARIFICATIONS NEEDED IN THE PLANS SHALL NEVER BE ASSUMED BY THE CONTRACTOR. THE ARCHITECT WILL CLARIFY ANY QUESTIONS, IF AND WHEN NEEDED IN A REASONABLE AND TIMELY MANNER.
- THE CONTRACTOR IS TO COORDINATE THE WORK OF ALL OTHER SUBCONTRACTORS AND TRADES, WHETHER HIS OWN OR THOSE OF ANY SEPARATE CONTRACTORS ACQUIRED BY THE OWNER.
- THE CONTRACTOR SHALL FURNISH AND INSTALL ALL MINOR ITEMS WHICH ARE OBVIOUS, REASONABLE AND NECESSARY TO COMPLETE ANY INSTALLATION.
- THE ARCHITECT ACCEPTS NO RESPONSIBILITY FOR THE QUALITY OF MATERIALS SELECTED AS REQUIRED BY THESE DWGS., NOR FOR THE WORKMANSHIP PROVIDED IN THE INSTALLATION OF THE SAME.
- DRAWINGS FROM VARIOUS DISCIPLINES ARE INTERRELATED, WHAT IS REQUIRED BY ONE SHALL BE AS BINDING AS IF REQUIRED BY ALL. COMPLEMENTARY COMPONENTS BETWEEN DISCIPLINES, REASONABLY INFERRED AS BEING NECESSARY TO PRODUCE INTENDED RESULTS SHALL BE DEEMED PART OF THE CONTRACTOR'S EXPECTED PERFORMANCE.
- THE CONTRACTOR SHALL BE RESPONSIBLE FOR IMMEDIATE AND DAILY CLEANING AND REMOVAL OF ALL DEBRIS UNTIL PREMISES ARE ACCEPTED IN A CLEAN, HABITABLE CONDITION BY OWNER.
- THE CONTRACTOR SHALL PROVIDE PROPER SAFEGUARD IN COMPLIANCE WITH LOCAL CODE AND ALL APPLICABLE CODES DURING ALL PHASES OF CONSTRUCTION.

SCOPE OF WORK

PROJECT	DESCRIPTION
MARY SAUNDERS PARK COMPUTER LAB BUILD-OUT	INTERIOR BUILD-OUT OF A COMPUTER LAB IN EXISTING OFFICE AND STORAGE SPACE AT PARK BUILDING, TO INCLUDE BUT NOT LIMITED TO INTERIOR DEMOLITION, NEW INTERIOR WINDOW, CEILINGS, REPLACEMENT OF DRYWALL, FLOORING, PAINTING, MILLWORK, ELECTRICAL WORK AND MINOR MECHANICAL WORK.
AREA OF WORK: 475 SF	
OWNER	
CITY OF WEST PARK	
TENANT	
N/A	
LOCATION	
4750 SW 21ST STREET WEST PARK, FL 33023	ALTERATIONS ARE CONSIDERED TO BE LEVEL 2 LEVEL OF REHABILITATION (NFPA 101 43.2.2.1) - MODIFICATION

MINIMUM FLAME SPREAD CLASSIFICATION FOR INTERIOR FINISHES

WALL AND CEILING FINISHES EXITS AND CORRIDORS	MINIMUM CLASSIFICATION CLASS A OR B
ROOMS & ENCLOSED AREAS	CLASS A, B OR C
INTERIOR FLOOR FINISHES	CLASS 1
FURNISHINGS	
DRAPERY & UPHOLSTERED FURNITURE	CLASS 1, NFPA 260 & MEET NFPA 701

GOVERNING CODES

- NOTE: NOT ALL THE FOLLOWING CODES MAY BE APPLICABLE.
- ADA STANDARDS FOR ACCESSIBLE DESIGN - 2010 EDITION
 - FLORIDA ACCESSIBILITY CODE - 2012 EDITION
 - FLORIDA BUILDING CODE (FBC) - 2010 EDITION
 - FLORIDA FIRE PREVENTION CODE - 2010 EDITION
 - NFPA 101 LIFE SAFETY CODE - 2012 EDITION
 - FLORIDA STATUTE 633 - LATEST EDITION

ZONING INFORMATION


ZONING DESIGNATION:	PARK (82)	
TAX FOLIO No.:	514219017140	
SETBACKS:	MINIMUM	PROPOSED
FRONT	N/A	NO CHANGE
REAR	N/A	NO CHANGE
SIDES	N/A	NO CHANGE
BUILDING HEIGHT:	MAXIMUM	PROPOSED
	N/A	NO CHANGE
F.A.R.:	N/A	NO CHANGE
LEGAL DESCRIPTION:	CARVER RANCHES 19-2 B ALL BLK. 39 DESIGNATED AS PARK AKA: PT OF CARVER RANCHES PARK	

CODE STATEMENT

TO THE BEST OF THE ARCHITECT'S / ENGINEER'S KNOWLEDGE, THE DRAWINGS AND SPECIFICATIONS SUBMITTED HEREIN ARE COMPLIANT WITH ALL APPLICABLE CODES AS DETERMINED BY THE LOCAL AUTHORITY.



AERIAL PLAN
SCALE: N.T.S.

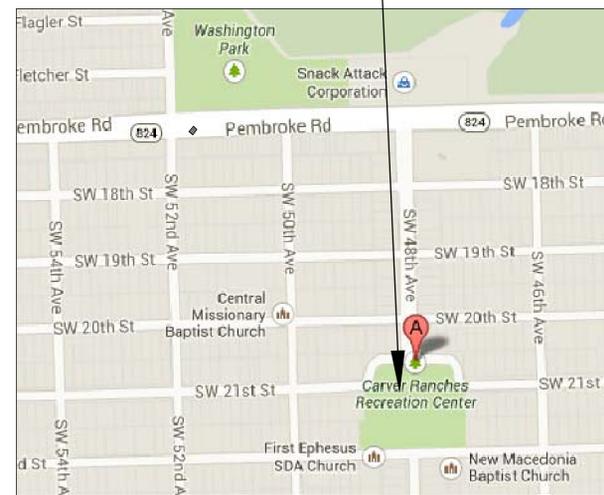

AREA MAP
SCALE: N.T.S.



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Architecture, Interiors & Project Management

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Zamarr T. Brown, RA

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REVISIONS


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08/01/14	Owner Changes
03/19/15	Bldg. Dept. Comments

SHEET TITLE
DWG INDEX
& GENERAL NOTES

DRAWING NO.

G0.01

ENGINEERING CONSORTIUM INC.
 ENGINEERING THE BUILT ENVIRONMENT
M. E. P. & FP ENGINEERS
 4907 N. UNIVERSITY DRIVE, SUITE 203
 LAUDERHILL, FLORIDA 33351
 TEL: (954) 635-5526 FAX: (954) 302-8570
 FLORIDA ENGINEERING FIRM CA #: 27353
 EOR: WAYNE A. WILLIAMS P.E. #: 72319
 ECI PROJECT #: 0113015

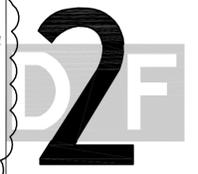

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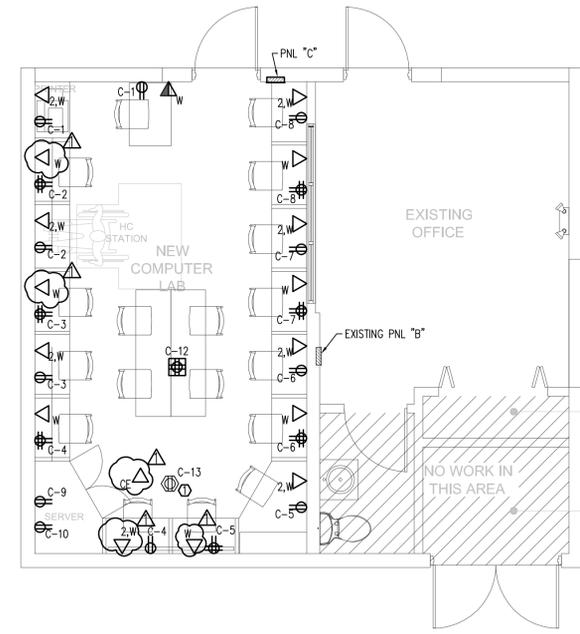
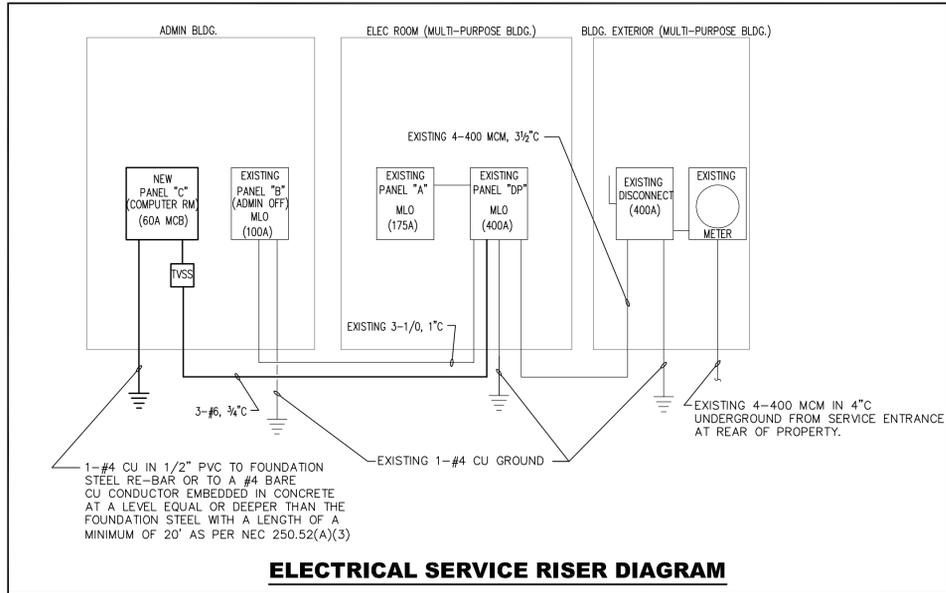


Wayne A. Williams, P.E.
 FILE NAME : E1.0
 DRAWN BY : R. Lee
 QA/QC BY : W. Williams
 JOB NO. : 13-014
 DATE : 11/06/13


09/27/13 As-built Dwg's
 10/03/13 100% CD's
 03/19/15 BLDG. DEPT. COMMENTS

ELECTRICAL FLOOR PLANS, SCHEDULES AND SINGLE-LINE RISER DIAGRAM

E1.1



ELECTRICAL - POWER/SYSTEMS PLAN
 SCALE: 1/4" = 1'-0"

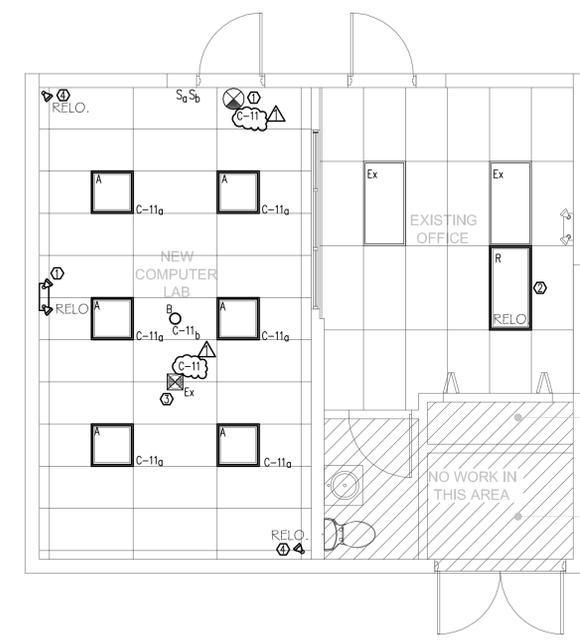

ELECTRICAL - LIGHTING/SYSTEMS PLAN
 SCALE: 1/4" = 1'-0"

NEW PANEL C

MAINS:		VOLTAGE:		WIRE:		MOUNTING:							
60 MCB		240/120		3		FLUSH							
BUS: 100 A		PHASE: 1		AIC: 10 kA		ENCLOSURE: NEMA 1							
CKT #	TRIP POLE	LOAD TYPE	AWG/ COND.	DESCRIPTION	CONNECTED LOAD KVA			DESCRIPTION	AWG/ COND.	LOAD TYPE	TRIP POLE	CKT #	
					KVA	PH A	PH B						
1	20	G	1#12, 1#12G, 3/4"C	PRINTER RECEPTACLE	1.5	2.8	1.3	COMPUTER STATION RECEPTACLE	1#12, 1#12G, 3/4"C	G	20	2	
3	20	G	1#12, 1#12G, 3/4"C	COMPUTER STATION RECEPTACLE	1.3		2.5	1.3	COMPUTER STATION RECEPTACLE	1#12, 1#12G, 3/4"C	G	20	4
5	20	G	1#12, 1#12G, 3/4"C	COMPUTER STATION RECEPTACLE	1.3	2.5	1.3	1.3	COMPUTER STATION RECEPTACLE	1#12, 1#12G, 3/4"C	G	20	6
7	20	G	1#12, 1#12G, 3/4"C	COMPUTER STATION RECEPTACLE	1.3		2.5	1.3	COMPUTER STATION RECEPTACLE	1#12, 1#12G, 3/4"C	G	20	8
9	20	G	1#12, 1#12G, 3/4"C	SERVER EQUIPMENT	0.8	1.5	0.8	0.8	SERVER EQUIPMENT	1#12, 1#12G, 3/4"C	G	20	10
11	20	A	1#12, 1#12G, 3/4"C	LIGHTS	0.5		1.5	1.0	FLOOR RECEPTACLE	1#12, 1#12G, 3/4"C	B	20	12
13	20	B	1#12, 1#12G, 3/4"C	OVERHEAD PROJECTOR	0.5	0.5			SPACE	1#12, 1#12G, 3/4"C	B	20	14
15				SPACE					SPACE				16
17				SPACE					SPACE				18
19				SPACE					SPACE				20
21				SPACE					SPACE				22
23				SPACE					SPACE				24
25				SPACE					SPACE				26
27				SPACE					SPACE				28
29				SPACE					SPACE				30

Panel Load Analysis									
Load Type	Description	Conn. KVA	Demand KVA	2008 NEC Reference	Load Type	Description	Conn. KVA	Demand KVA	2008 NEC Reference
A	Lighting	0.5	0.5	Per NEC Table 220.12	F	Kitchen Equipment			Per NEC Table 220.58
B	Receptacles	1.5	1.5	Per NEC Table 220.44	F	Motor			Per NEC Table 430.22-26
C	Air-Conditioning			Per NEC Article 440.6	G	Other	11.8	11.8	
D	Heating			Per NEC Article 220.60					
Phase A Connected Load		7.3		TOTAL CONNECTED LOAD:	13.8 KVA		LOAD AMPS: 57.3		LOCATION: NEW COMPUTER ROOM
Phase B Connected Load		6.5		TOTAL DEMAND LOAD:	13.8 KVA				

EXISTING PANEL "DP"

MAINS:		VOLTAGE:		WIRE:		MOUNTING:						
MLO		240/120		4		SURFACE						
BUS: 400 A		PHASE: 3		AIC: 10 kA		ENCLOSURE: NEMA 1						
CKT #	TRIP POLE	LOAD TYPE	AWG/ COND.	DESCRIPTION	CONNECTED LOAD KVA			DESCRIPTION	AWG/ COND.	LOAD TYPE	TRIP POLE	CKT #
					KVA	PH A	PH B					
1	40	F		AHU-1	1.9	1.9		10.5		G	175	4
3		F			1.9		12.4	10.5		G		6
5		F			1.9		12.4	10.5		G		8
7	50	C			6.0	16.5	16.5	10.5		G		10
9		C		HEAT	6.0		16.5	10.5		G		12
11		C			6.0		18.0	12.0		G	100	14
13				SPACE			12.0	12.0		G	2	16
15				SPACE			7.8	7.8		C	70	18
17	20	G		EQUIPMENT	1.0		8.8	7.8		C		20
19	20	G		EQUIPMENT	1.0	8.8	7.8	7.8		C	3	22
21				SPACE			7.8	7.8		C	70	24
23	60	G	#6, #10G, 1"C	PANEL "C"	6.9		14.7	7.8		C		26
25		G			6.9		14.7	7.8		C		28
27				SPACE								30
29				SPACE								32
31				SPACE								34
33				SPACE								36
35				SPACE								38
37				SPACE								40
39				SPACE								42

Panel Load Analysis									
Load Type	Description	Conn. KVA	Demand KVA	2008 NEC Reference	Load Type	Description	Conn. KVA	Demand KVA	2008 NEC Reference
A	Lighting			Per NEC Table 220.12	E	Kitchen Equipment			Per NEC Table 220.58
B	Receptacles			Per NEC Table 220.44	F	Motor	5.8	6.3	Per NEC Table 430.22-26
C	Air-Conditioning	64.8	64.8	Per NEC Article 440.6	G	Other	81.8	81.8	
D	Heating			Per NEC Article 220.60					
Phase A Connected Load		53.9		TOTAL CONNECTED LOAD:	152.4 KVA		LOAD AMPS: 387.9		LOCATION:
Phase B Connected Load		44.5		TOTAL DEMAND LOAD:	152.9 KVA				
Phase C Connected Load		53.9		TOTAL DEMAND LOAD:	152.9 KVA				

SERVICE SUMMARY

EXISTING MAXIMUM DEMAND LOADS BASED ON FPL ACTUAL DEMAND OVER 12 MONTHS PERIOD: JANUARY 2013 THRU DECEMBER 2013 = 33 KW

EXISTING MAXIMUM DEMAND OVER 12 MONTHS = 33 KW
 EXISTING MAXIMUM LOAD = (33,000W x 1.25)/(240V x 1.7321) = APPROX. 100A

ADDED LOAD:
 PANEL "C" = 13,800W/240V = 57.5A

TOTAL DEMAND LOAD:
 EXISTING MAX DEMAND + ADDED DEMAND = 100A + 57.5A = 157.5A

SERVICE SIZE:
 EXISTING TO REMAIN: 400 A
 WIRE SIZE: EXISTING TO REMAIN: (3) 400 MCM, 4"C
 (NOTE: SERVICE ENTRANCE IS EXISTING, EXTERIOR AND RATED AT 90F)

GENERAL NOTES:
 1. DATA/COMMUNICATION SYSTEM: DATA/COMMUNICATION OUTLET LOCATION ONLY SHOWN. SYSTEM DESIGN AND LAYOUT/ROUTING BY OTHERS.

KEYED NOTES:
 ① FOR USE WITH FUTURE PROJECTOR. COORDINATE EXACT LOCATION OF RECEPTACLE IN CEILING WITH ARCHITECT/USER IN THE FIELD.

KEYED NOTES:
 ① RELOCATED/RELOCATED EMERGENCY EXIT LIGHT FIXTURE, CONNECT TO CIRCUIT AHEAD OF SWITCHING.
 ② EXISTING LIGHT FIXTURE RELOCATED FROM EXISTING STORAGE ROOM. CONNECT TO AND SWITCH WITH EXISTING CIRCUIT SERVING EXISTING FIXTURES IN OFFICE.
 ③ CONNECT SMOKE DETECTOR TO CIRCUIT AHEAD OF SWITCHING.
 ④ CAMERA RELOCATED BY OWNER'S SECURITY VENDOR.

